INTERIOR REMODEL COMPUTER BANK

1545 NORTH 11TH STREET SPRINGFIELD, ILLINOIS

ARCHITECT:



1630 South Sixth Street Springfield, Illinois 62703 Phone 217.789.7011

GENERAL NOTES

- CONTRACTOR SHALL VERIFY ALL DIMENSIONS IN THE FIELD AND SHALL NOTIFY THE ARCHITECT OF ANY DISCREPANCIES. ALL WORK REQUIRING MEASURING SHALL BE DONE ACCORDING TO THE DIMENSIONS ON THE DRAWINGS AND NOT SCALED FROM DRAWINGS. THE ARCHITECT WILL FURNISH ANY ADDITIONAL DIMENSIONS UPON REQUEST.
- ALL WORK SHALL CONFORM TO PREVAILING CODES, ORDINANCES AND REQUIREMENTS.
- 3. CONTRACTOR IS RESPONSIBLE TO OBTAIN ALL PERMITS AND INSPECTIONS REQUIRED FOR CONSTRUCTION, AND SHALL PAY ALL APPLICABLE FEES. THE OWNER HAS APPLIED FOR THE CITY OF SPRINGFIELD BUILDING PERMIT AND PAID THE PLAN REVIEW FEE. THE PERMIT ISSUANCE FEE SHALL BE PAID BY THE CONTRACTOR.
- 4. CONTRACTOR SHALL PROVIDE THE OWNER WITH A WRITTEN ONE (1) YEAR GUARANTEE COVERING ALL LABOR AND MATERIALS FURNISHED AND INSTALLED AS PART OF THIS PROJECT. GUARANTEE SHALL COMMENCE FROM THE DATE OF SUBSTANTIAL COMPLETION.
- 5. THE HVAC AND ELECTRICAL CONTRACTORS SHALL BE REGISTERED WITH THE CITY OF SPRINGFIELD
- 6. PERMITS ARE REQUIRED BEFORE STARTING OF WORK

BUILDING CODE SUMMARY

GOVERNING CODES: 2012 INTERNATIONAL BUILDING CODE

00 NFPA 101 LIFE SAFETY CODE

SPRINGFIELD BUILDING ORDINANCE, CHAPTER 170

2012 INTERNATIONAL MECHANICAL CODE 2012 INTERNATIONAL FUEL GAS CODE

SPRINGFIELD MECHANICAL ORDINANCE, CHAPTER 173

NATIONAL ELECTRICAL CODE SPRINGFIELD ELECTRICAL ORDINANCE, CHAPTER 172

2014 ILLINOIS STATE PLUMBING CODE SPRINGFIELD PLUMBING ORDINANCE, CHAPTER 171

1997 ILLINOIS ACCESIBILITY CODE

2006 INTERNATIONAL FIRE CODE

SPRINGFIELD FIRE SAFETY ORDINANCE, CHAPTER 94 SPRINGFIELD ZONING ORDINANCE, MARCH 2005

2015 INTERNATIONAL ENERGY CONSERVATION CODE

USE GROUP CLASSIFICATION

В

CONSTRUCTION CLASSIFICATION

5B (NON-SPRINKLERED)

1,388 S.F.

TOTAL PROJECT AREA

INDEX TO DRAWINGS

G-1 COVER SHEET

A-1 FLOOR PLAN, CEILING PLAN

HV-1 HVAC PLAN, SCHEDULES, NOTES

E-1 ELECTRICAL PLANS E-2 SCHEDULES, NOTES TIMOTHY

B. SMITH

001-017445

Date Signed: APRIL 9, 2018

Expiration Date: NOV. 30, 2018

630 South Sixth Street Springfield, Illinois 6270; Phone 217 789 7011



COMPUTER BANK
1545 NORTH 11TH STREET

Date: APRIL 9, 2018

Date: APRIL 9, 201

....


Revised:

SHEET

G-1

OF 5 SHEETS

© Evan Lloyd Associates, Inc.

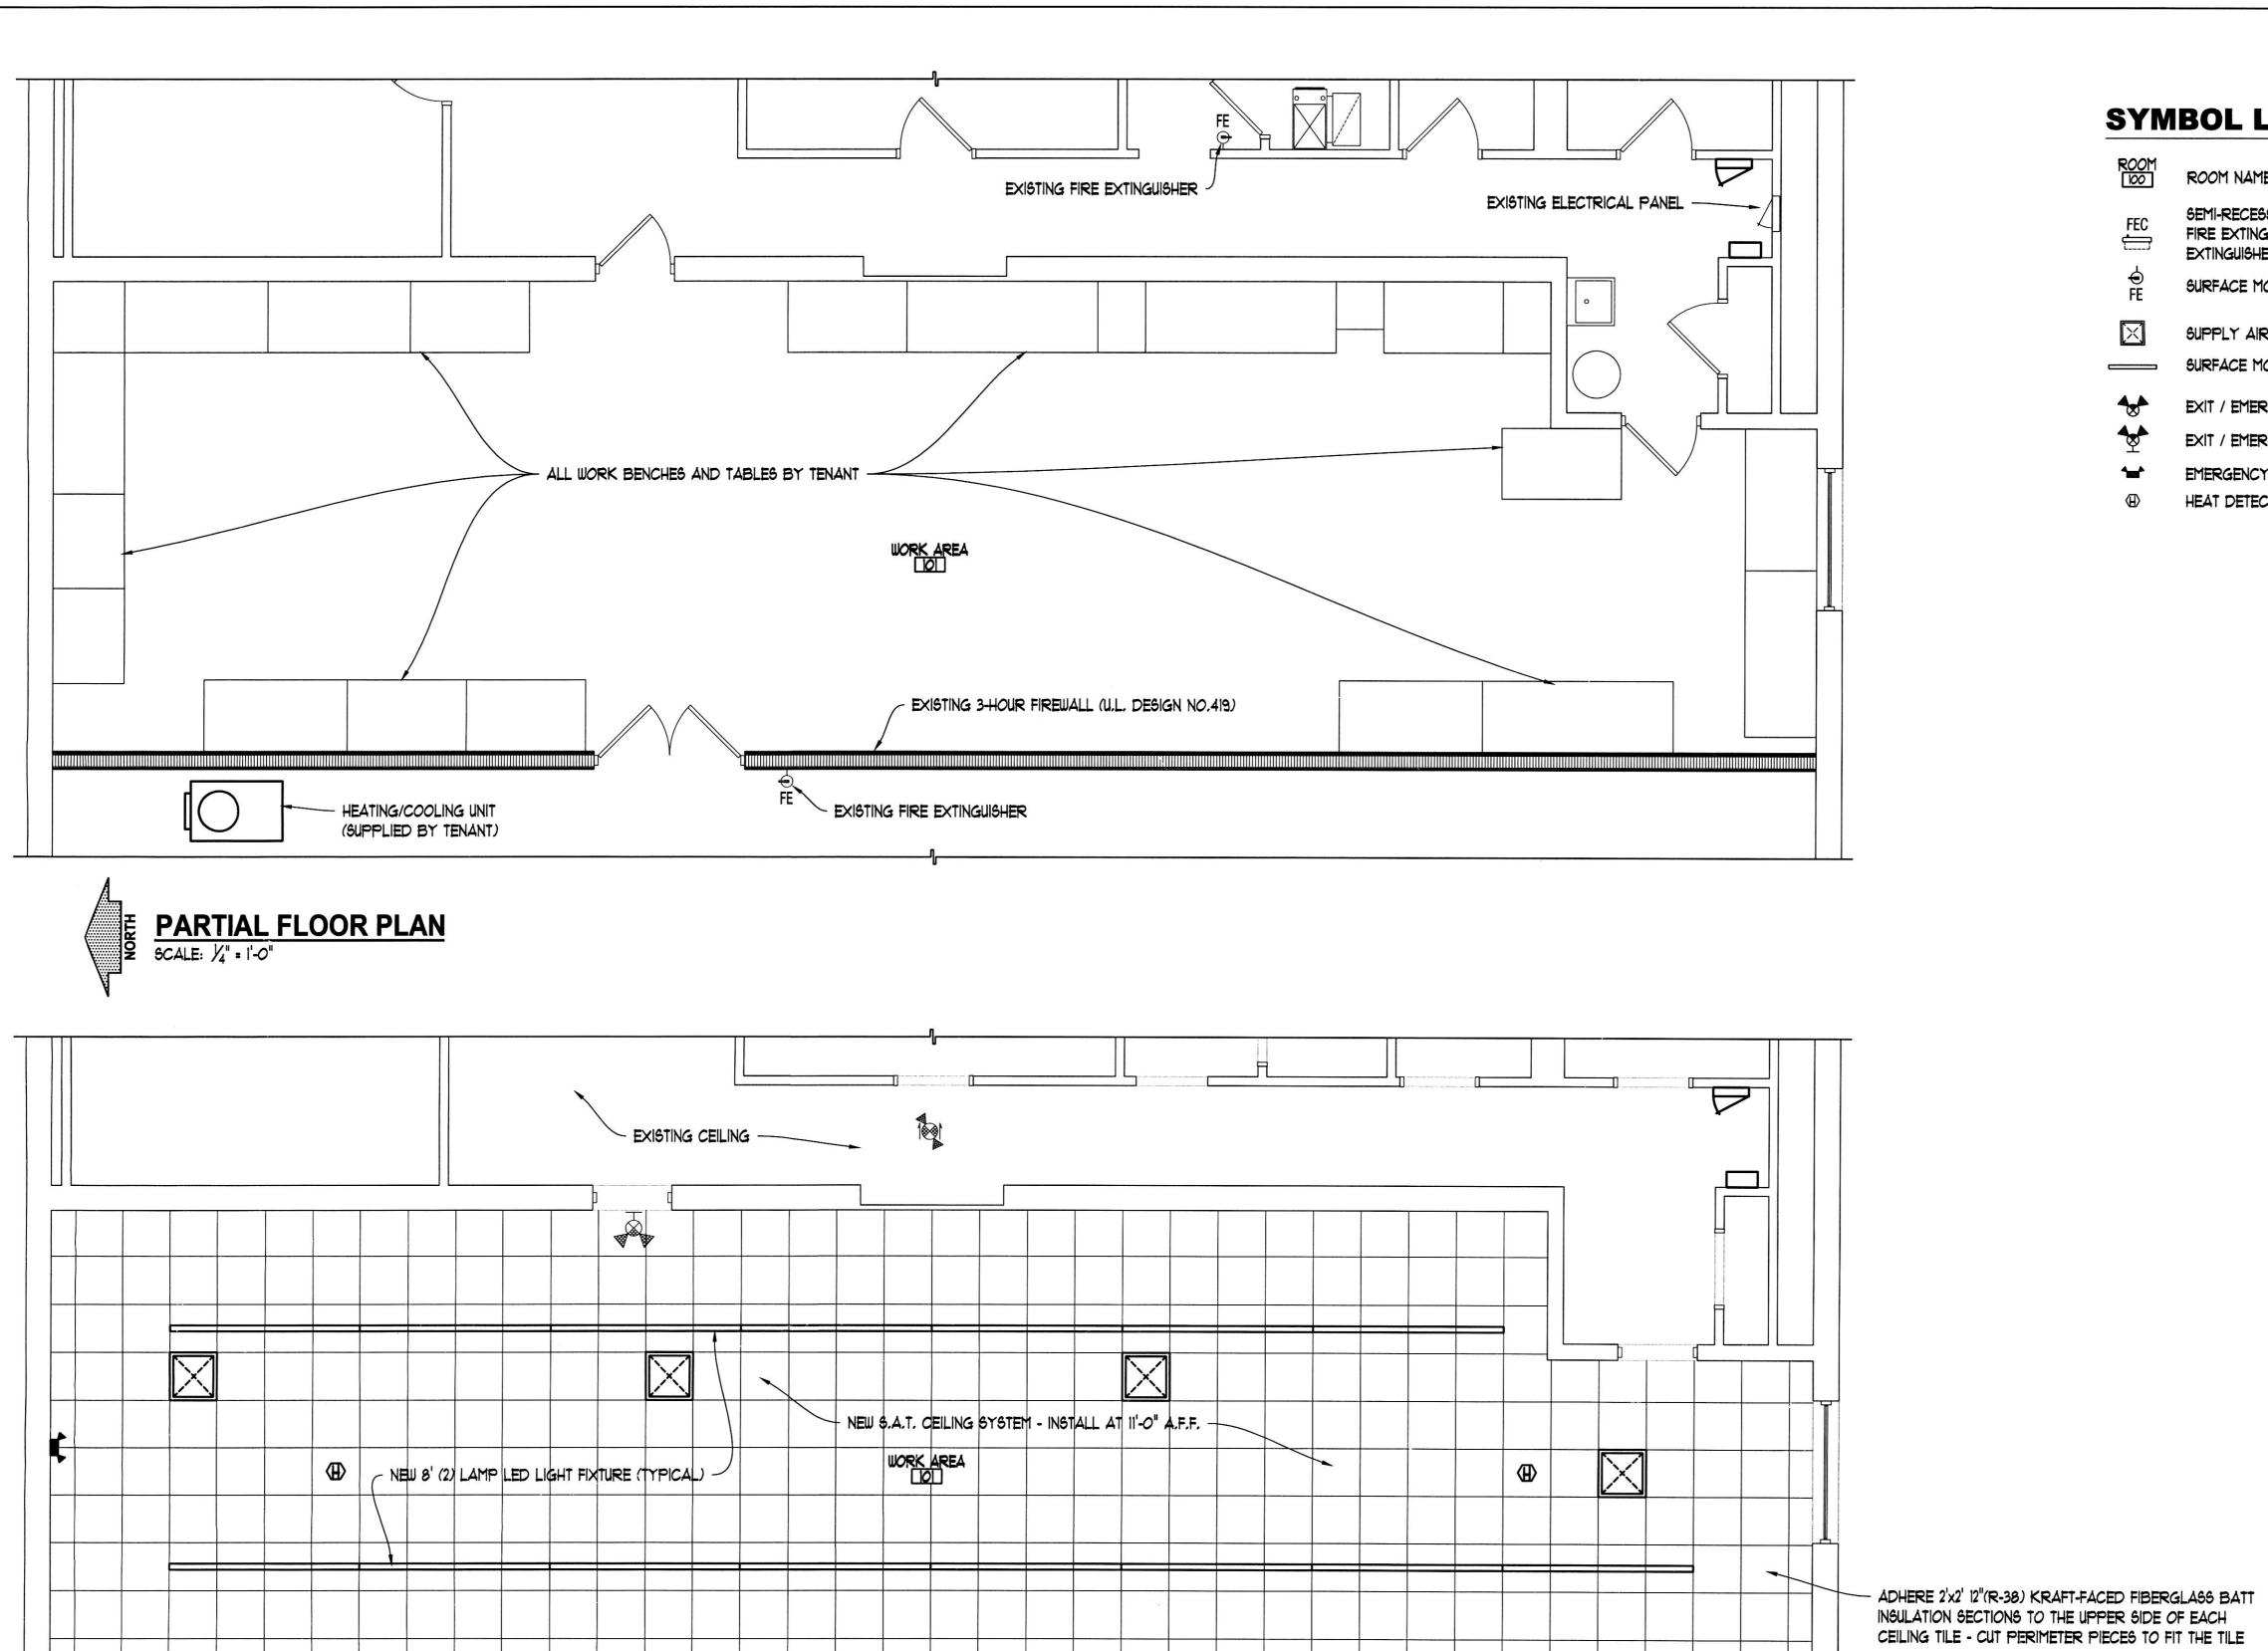

PARTIAL CEILING PLAN

SCALE: 1/4" = 1'-0"

EXISTING 3-HOUR FIREWALL (U.L. DESIGN NO.419)

SYMBOL LEGEND

ROOM NAME AND NUMBER

SEMI-RECESSED WALL MOUNTED FIRE EXTINGUISHER CABINET (5 LB. EXTINGUISHER U.N.O.)

SURFACE MOUNTED FIRE EXTINGUISHER

SUPPLY AIR DIFFUSER SURFACE MOUNTED FIXTURE

EXIT / EMERGENCY SIGN (CEILING MOUNTED)

EXIT / EMERGENCY SIGN (WALL MOUNTED)

EMERGENCY LIGHT FIXTURE

HEAT DETECTOR

Date Signed: APRIL 9, 2018

Expiration Date: NOV. 30, 2018

INTERIOR REMODEL

COMPUTER BANK
1545 NORTH 11TH STREET
SPRINGFIELD, ILLINOIS

Date: APRIL 9, 2018

Project No. 8-021

OF 5 SHEETS

© Evan Lloyd Associates, Inc.

ELECTRICAL SYMBOLS LIST

SURFACE MOUNTED LIGHT FIXTURE (SEE SCHEDULE)

WALL MOUNTED SELF-CONTAINED EMERGENCY LIGHT FIXTURE W/ TWIN HEADS & BATTERY PACK (SEE SCHEDULE)

EXISTING WALL MOUNTED COMBINATION EXIT SIGN W/ TWIN

HEAD EMERGENCY LIGHTS

EXISTING CEILING MOUNTED COMBINATION EXIT SIGN W/ TWIN HEAD EMERGENCY LIGHTS & ONE-WAY DIRECTIONAL ARROW ON BOTH SIDES

SWITCH OUTLET IN A SINGLE GANG BOX (4'-0" A.F.F. TO CENTER

OF OUTLET BOX)

LOWER CASE LETTER INDICATES SWITCH CONTROLLED CIRCUIT

CEILING MOUNTED RATE-OF-RISE HEAT DETECTOR

AUDIO/VISUAL FIRE ALARM DEVICE MOUNT @ 6'-8" A.F.F. TO TOP OF LENS, PROVIDE 3/4" CONDUIT STUBBED ABOVE ACCESSIBLE CEILING

(IIO CD) THE INFORMATION IN PARENTHESIS INDICATES CANDELA RATING

DUPLEX CONVENIENCE OUTLET (1'-6" A.F.F. TO BOTTOM OF BOX, UNLESS NOTED OTHERWISE)

QUADRUPLEX CONVENIENCE OUTLET (1'-6" A.F.F. TO BOTTOM OF BOX, UNLESS OTHERWISE NOTED)

SPECIAL OUTLET

JUNCTION BOX

FUSED DISCONNECT SWITCH

CONDUIT EXPOSED ON CEILING OR WALL

CONDUIT CONCEALED ABOVE CEILING OR IN WALL

INDICATES NO. OF *12 WIRES IN 1/2" CONDUIT OR LARGER


INDICATES CONTINUOUS COPPER GROUND WIRE IDENTIFIED BY GREEN IN COLOR

HOME RUN TO PANEL, LETTER INDICATES PANEL LOCATION & NUMBERS

INDICATE CIRCUITS


SURFACE MOUNTED ELECTRICAL PANEL

EXISTING RECESSED MOUNTED ELECTRICAL PANEL

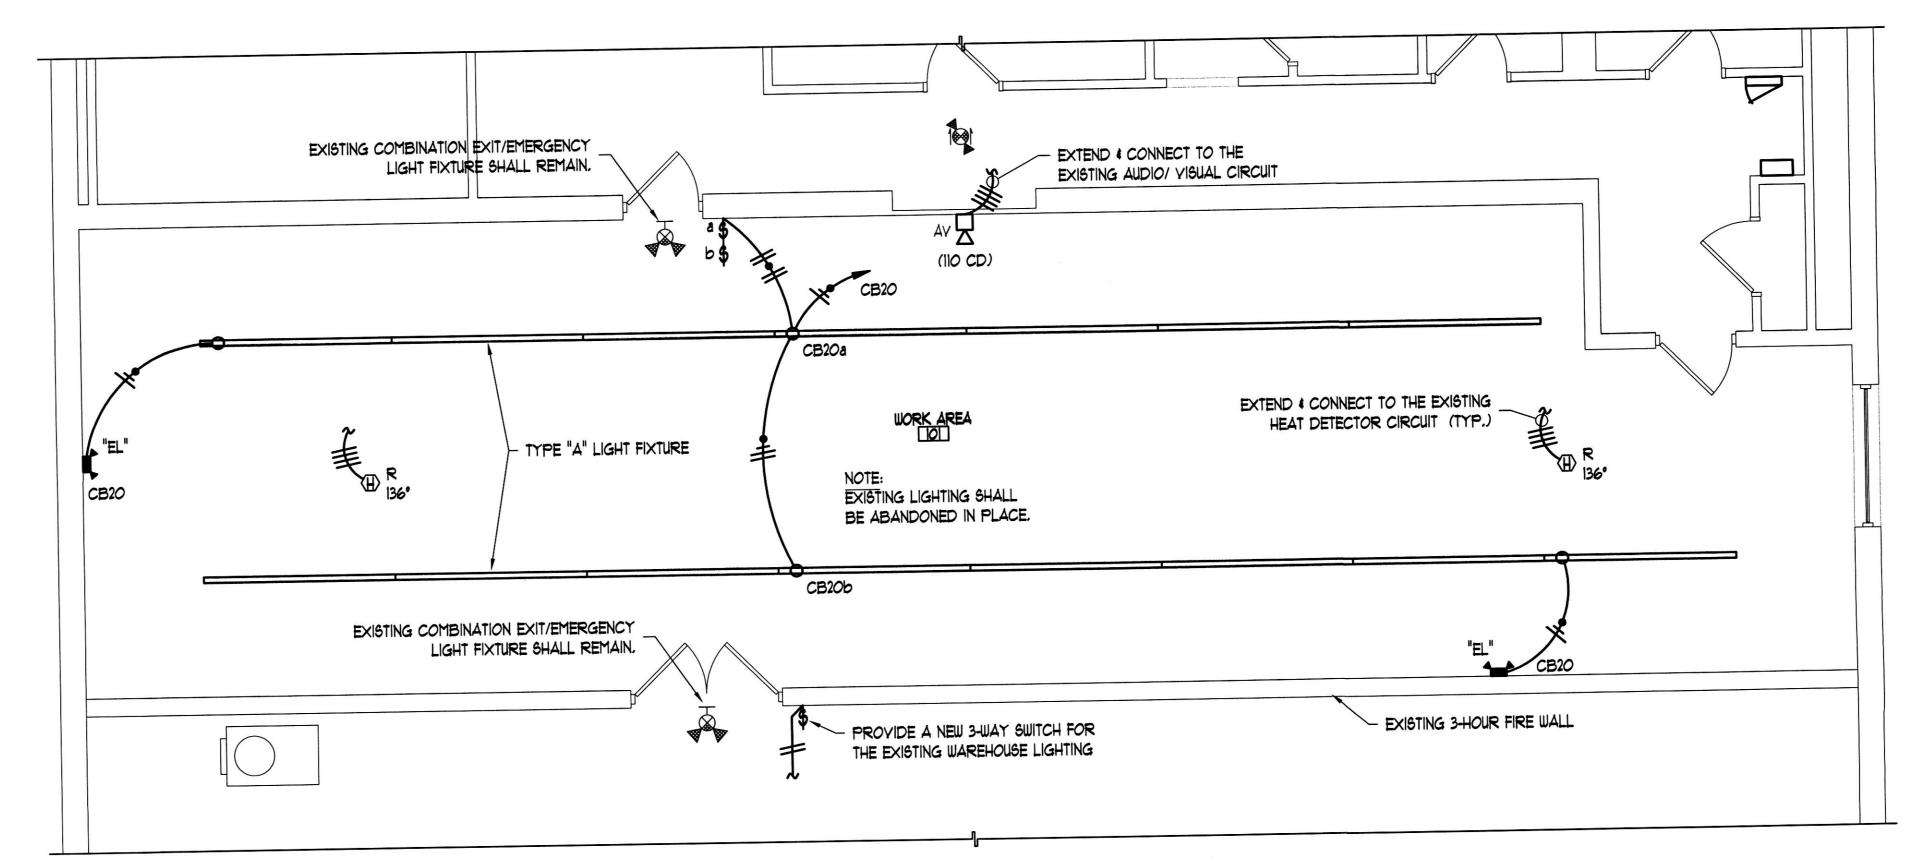




LIGHTING & FIRE ALARM PLAN SCALE: 14" = 1'-0"

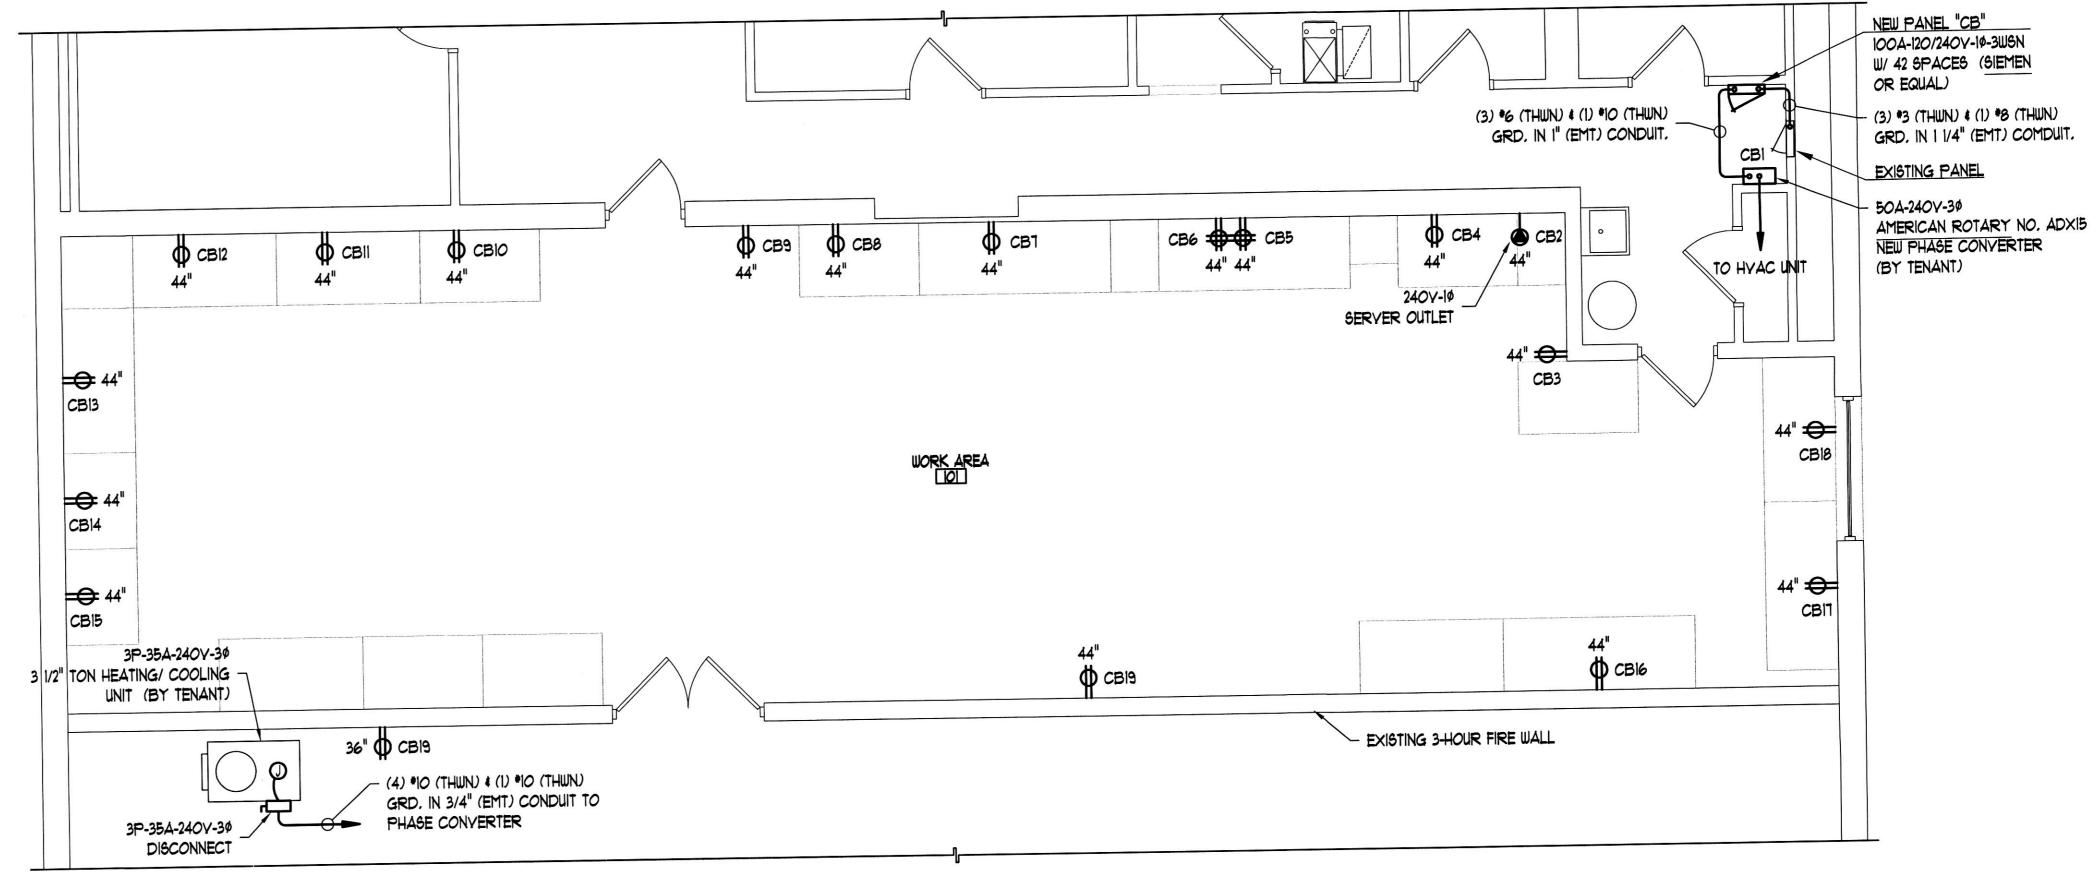



CONVENIENCE OUTLETS & POWER PLAN SCALE: 14" = 1'-0"

© Evan Lloyd Associates, Inc.

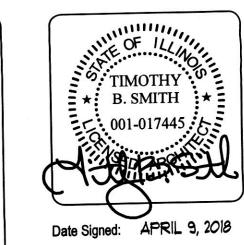

Expiration Date: NOY. 30, 2018

COMPUTER BANK 1545 NORTH 11TH STREET SPRINGFIELD, ILLINOIS INTERIOR REMODEL

Date: APRIL 9, 2018 Project No. 18-021 Drawn By: TCR, BH

Revised:

SHEET

E-1

OF 5 SHEETS

GENERAL ELECTRICAL NOTES


- 1. ALL WORK SHALL BE PERFORMED BY A LICENSED ELECTRICIAN REGISTERED WITH THE CITY OF SPRINGFIELD IN STRICT ACCORDANCE IN STRICT ACCORDANCE WITH THE NATIONAL ELECTRICAL CODE, THE INTERNATIONAL ENERGY CODE AND ALL REGULATIONS, LAWS, AND ORDINANCES WHICH MAY BE APPLICABLE. SEE COVER SHEET G-I FOR THE LATEST ADOPTED EDITIONS.
- 2. THE ELECTRICAL SUBCONTRACTOR SHALL REFER TO THE ARCHITECTURAL AND MECHANICAL DRAWINGS DURING BIDDING AND CONSTRUCTION TO AVOID ANY, AND ALL CONFLICTS.
- 3. ALL POWER WIRE IS TO BE COPPER WITH "THWN", "THHW" OR "THHN" INSULATION. TYPE "AC", "BX", OR "NM" CABLES WILL NOT BE PERMITTED ON THIS PROJECT. ALL EXPOSED CONDUIT IS TO BE "EMT" TYPE CONDUIT WITH SET SCREWS OR COMPRESSION FITTINGS. ALL CONCEALED CONDUIT CAN BE PLASTIC FLEXIBLE CONDUIT WITH APPROVED FITTINGS AND BOXES AT CONTRACTOR'S OPTION.
- 4. THE ELECTRICAL SUBCONTRACTOR IS RESPONSIBLE FOR ALL HANGERS, CLIPS, MOUNTING HARDWARE, ETC.
- 5. THE ELECTRICAL SUBCONTRACTOR SHALL INSTALL THE ELECTRICAL CONDUITS A MINIMUM OF 6 INCHES ABOVE THE CEILING GRID. ALL LOW YOLTAGE WIRING SHALL BE INSTALLED OFF THE GRID AND ATTACHED TO THE STRUCTURE ABOVE AT 4-1/2 FEET APART.
- 6. THE ELECTRICAL SUBCONTRACTOR SHALL PROVIDE ALL POWER AND FIRE ALARM WIRING. COORDINATE WITH RESPECTIVE CONTRACTORS FOR EQUIPMENT WIRING AND CONTROLS.
- 7. THE ELECTRICAL SUBCONTRACTOR SHALL INSTALL ALL SAFETY SWITCHES NOT FACTORY INSTALLED WITH EQUIPMENT, AND MAKE FINAL CONNECTIONS TO EQUIPMENT.
- 8. THE ELECTRICAL SUBCONTRACTOR SHALL VERIFY FINAL WALL LOCATIONS OF OUTLETS WITH THE OWNER PRIOR TO INSTALLATION.
- 9. ALL FACE PLATE, SWITCH AND OUTLET COLORS SHALL BE IVORY IN COLOR.
- 10. THE ELECTRICAL SUBCONTRACTOR SHALL COORDINATE BREAKER AND WIRING SIZING WITH EQUIPMENT PRIOR TO INSTALLING, AND IF ANY DISCREPANCIES ARE FOUND, NOTIFY THE ARCHITECT PRIOR TO EXECUTING THE
- 11. THE ELECTRICAL SUBCONTRACTOR SHALL PROVIDE A SINGLE GANG GALVANIZED BOX FOR TELEPHONE OUTLETS WITH 3/4" EMPTY CONDUIT STUBBED ABOVE ACCESSIBLE CEILINGS.
- 12. ALL NEW ELECTRICAL PANELS SHALL BE SIEMENS TYPE OR APPROVED EQUAL.
- 13. THE ELECTRICAL SUBCONTRACTOR SHALL VERIFY VOLTAGE AND PHASE PRIOR TO ROUGH-INS.
- 14. THE ELECTRICAL SUBCONTRACTOR SHALL PROVIDE TYPED PANEL INDEX FOR NEW PANELS, AND PROVIDE A PERMANENT LABEL ON THE OUTSIDE OF THE PANELS INDICATING PANEL DESIGNATION.
- 15. THE ELECTRICAL SUBCONTRACTOR SHALL USE NO: 10 WIRE FOR 20A, 120Y BRANCH CIRCUIT HOME RUNS LONGER THAN 15 FEET.
- 16. THE ELECTRICAL SUBCONTRACTOR SHALL SEAL ALL ELECTRICAL PENETRATIONS THROUGH EXTERIOR WALLS TO MAINTAIN AN AIR AND WATER TIGHT SEAL.
- 17. THE ELECTRICAL SUBCONTRACTOR SHALL PROVIDE FIRESTOPPING AT ALL PENETRATIONS THROUGH FIRE-RATED WALLS AND CEILINGS.
- 18. ALL STANDARD OUTLETS AND SWITCHES SHALL BE RATED FOR A MINIMUM OF 20A, 120Y.
- 19. ALL TELEPHONE WIRING SHALL BE PROVIDED BY THE OWNER.
- 20. ALL SECURITY DEVICES, FIRE ALARM DEVICES, CABLES AND CATY CABLES SHALL BE PROVIDED BY THE OWNER.
- 21. THE ELECTRICAL SUBCONTRACTOR SHALL PROVIDE EMPTY BOXES AND CONDUIT STUBBED ABOVE ACCESSIBLE CEILINGS, OR 10'-O" ABOVE THE FINISHED FLOOR IN EXPOSED AREAS FOR COMMUNICATION/ DATA OUTLETS. ALL COAXIAL CABLE, CONNECTION DEVICES AND FACE PLATES FOR TY'S BY OTHERS.
- 22. THE ELECTRICAL SUBCONTRACTOR SHALL YERIFY FINAL WALL LOCATIONS OF YOICE/ DATA OUTLETS WITH THE OWNER PRIOR TO INSTALLATION.
- 23. THE ELECTRICAL SUBCONTRACTOR SHALL PROVIDE EMPTY BOXES & CONDUITS FOR FIRE ALARM DEVICES.
- 24. THE ELECTRICAL SUBCONTRACTOR SHALL PROVIDE (3) SETS OF SHOP DRAWINGS: (1) SET FOR THE GENERAL CONTRACTOR, (1) SET FOR THE OWNER AND (1) SET FOR THE ARCHITECT. PROVIDE (1) OPERATION AND MAINTENANCE MANUAL FOR THE OWNER. THE OPERATION AND MAINTENANCE MANUAL SHALL INCLUDE BASIC DATA RELATING TO THE OPERATION AND MAINTENANCE OF SYSTEMS AND EQUIPMENT.
- 25. THE ELECTRICAL SUBCONTRACTOR SHALL BE RESPONSIBLE FOR HIS OWN CUTTING AND PATCHING. COORDINATE WITH THE GENERAL CONTRACTOR.
- 26. PROVIDE IT LB. PULL STRING FOR EMPTY CONDUITS.

LIGHTING FIXTURE SCHEDULE											
TYPE	NUMBER AND TYPE OF LAMPS	MANUFACTURIER AND MODEL NUMBER	FIXTURE	MOU		FINISH	MATERIAL	LENS TYPE	VOLTAGE	REMARKS	
			SIZE	CEILING MATERIAL	WALL MATERIAL						
"A"	LED-4000K	LITHONIA NO. MNSL-96L-2LL-GZN-80CRI OR PRE-APPROYED EQUAL	2"x96"	SURFACE/ S.A.T.		WHITE	STEEL	ACRYLIC	MYOLT	-	
"EL"	LED	LITHONIA NO. UE2-LED-HO-M6 OR PRE-APPROYED EQUAL	5"xl4"		SURFACE/ DRYWALL	WHITE	PLASTIC	N/A	MYOLT	1, 2	

REMARKS:

- 1. PROVIDE A BUILT-IN BATTERY PACK, MOUNT AT 10'-0" AFF
- 2. MOUNT BOTTOM OF FIXTURE AT 10'-0" AFF

PANEL: LOCATION FED FRO			C DEVICE TYPE: BREEVICE FAMILY: BOLT-	AKER ON	ENCLO MOUNT VOLTA	ING:	NEMA 1 BURFACE 0/240Y-19	5	MAINS(A): 2P-100A WIRING: 1 PHASE-3 WI	RE	compression and the contract of the contract o	10,000 VERIFY
SPACE	LOCATION	CCT.#	DEMAND CODE	VA	OC AMPS-P	PHASE	OC AMPS-P	VA	DEMAND CODE CCT. #		LOCATION	SPACE
3	EXISTING CORRIDOR	1	PHASE CONVERTER	522 <i>O</i>	50-2	A B	20-2	4000 4000	SERVER 2		WORK AREA	2
5	WORK AREA	3	CONY, OUTLET	20-1	800	A	20-1	800	CONY, OUTLET	4	WORK AREA	6
7	WORK AREA	5	CONY, OUTLET	20-1	800	В	20-1	800	CONY, OUTLET	6	WORK AREA	8
9	WORK AREA	7	CONY, OUTLET	20-1	800	A	20-1	800	CONY, OUTLET	8	WORK AREA	10
11	WORK AREA	9	CONY, OUTLET	20-1	800	В	20-1	800	CONY, OUTLET	10	WORK AREA	12
13	WORK AREA	11	CONY, OUTLET	20-1	800	A	20-1	800	CONY, OUTLET	12	WORK AREA	14
15	WORK AREA	13	CONY, OUTLET	20-1	800	В	20-1	800	CONY, OUTLET	14	WORK AREA	16
17	WORK AREA	15	CONY, OUTLET	20-1	800	A	20-1	800	CONY, OUTLET	16	WORK AREA	18
19	WORK AREA	17	CONY, OUTLET	20-1	800	В	20-1	800	CONY, OUTLET	18	WORK AREA	20
21	WORK AREA	19	CONY, OUTLET	20-1	800	A	20-1	800	SPARE	20		22
23		21	SPARE	20-1	800	m	20-1	800	SPARE	22		24
25		23	SPARE	20-1	800	4	20-1	800	SPARE	24		26
27		25	SPARE	20-1	800	В	20-1	800	SPARE	26		28
BALANC			5.8 PH/	ASE TOTA ASE A ASE B	ILS 18,820 18,820	156	/A 6.8 6.8					

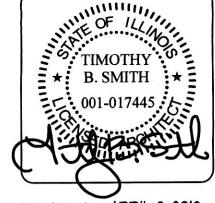

Date Signed: APRIL 9, 2018

Expiration Date: NOV. 30, 2018

1630 South Sixth Street Springfield, Illinois 62703 Phone 217 789 7011



COMPUTER BANK 1545 NORTH 11TH STREET SPRINGFIELD, ILLINOIS

Date: APRIL 9, 2018

Date: AFRIL 5, 20

Drawn By: TCR, BH

Project No. 18-021

Revised:

Revised: ,

E-2

© Evan Lloyd Associates, Inc. OF 5 SHEETS

DIFFUSER, REGISTER AND GRILLE SCHEDULE												
MARK	MANUFACTURER AND MODEL NUMBER	CFM	NECK SIZE	THROW PATTERN	LENGTH OF THROW	MOUNTING	FACE	MATERIAL	FINISH	UBAGE	OPPOSED BLADE DAMPER	REMARK8
"A"	PRICE NO. 24x24-5CDA-B12 OR PRE-APPROVED EQUAL	SEE DWG.	SEE DWG.	4 - WAY	'E OT 'T	S.A.T. CEILING	LOUYERED	STEEL	WHITE	SUPPLY	YE6	1, 2, 3
"B"	PRICE NO. 530-B12 OR PRE APPROVED EQUAL	SEE DWG.	SEE DWG.	N/A	N/A	G.B. WALL	LOUYERED	STEEL	WHITE	RETURN	NO	

REMARKS:


I. PROVIDE FULL FACE.

- 2. PROVIDE INSULATION ON BACK OF DIFFUSER.
- 3. PROVIDE AN ADJUSTABLE AIR PATTERN.

GENERAL HVAC NOTES


- 1. ALL HYAC WORK SHALL BE PERFORMED IN STRICT ACCORDANCE WITH THE INTERNATIONAL MECHANICAL CODE, THE INTERNATIONAL FUEL GAS CODE, THE INTERNATIONAL ENERGY CODE AND ALL REGULATIONS, LAWS AND ORDINANCES WHICH MAY BE APPLICABLE. SEE COVER SHEET G-I FOR THE LATEST ADOPTED EDITIONS.
- 2. THE HYAC SUBCONTRACTOR SHALL BE REGISTERED WITH THE CITY OF SPRINGFIELD.
- 3. THE HYAC SUBCONTRACTOR SHALL BE RESPONSIBLE FOR HIS OWN CUTTING AND PATCHING. COORDINATE WITH THE GENERAL CONTRACTOR AND OTHER TRADES.
- 4. THE GENERAL CONTRACTOR SHALL PROVIDE OPENING AND STRUCTURAL BRACING AROUND OPENINGS THRU WALLS AND ROOF. HYAC SUBCONTRACTOR SHALL COORDINATE OPENING SIZES AND LOCATIONS WITH GENERAL CONTRACTOR.
- 5. COORDINATE ALL THE NEW PENETRATIONS WITH STRUCTURAL ELEMENTS. YERIFY WITH THE ARCHITECT PRIOR TO CUTTING OPENINGS IN STRUCTURAL MEMBERS.
- 6. THE HYAC SUBCONTRACTOR SHALL COORDINATE VOLTAGE AND PHASE OF EACH PIECE OF EQUIPMENT WITH THE ELECTRICAL CONTRACTOR PRIOR TO ORDERING.
- 1. THE HYAC SUBCONTRACTOR SHALL FURNISH AND INSTALL 24 GAUGE GALYANIZED RIGID DUCT FOR SUPPLY, RETURN AND RESTROOM EXHAUST DUCTWORK. FLEX DUCT MAY ONLY BE USED IN RUNS OF 5'-O" OR LESS AT THE END OF THE DUCT RUN.
- 8. THE HYAC SUBCONTRACTOR SHALL INSTALL DUCTWORK TO MEET THE FIELD CONDITIONS
- 9. DUCT SIZES ARE SHOWN AS OUTSIDE CLEAR DIMENSIONS. ALL INTERIOR SUPPLY AND RETURN DUCTWORK SHALL HAVE A MINIMUM OF R-5 INSULATION VALUE (MINIMUM OF I" DUCT LINER)
- 10. ALL SUPPLY AND RETURN BRANCH DUCTWORK SIZES SHALL BE BASE ON THE NECK SIZE OF THE DIFFUSER UNLESS NOTED OTHERWISE. ALL OUTSIDE DIMENSIONS OF THE BRANCH DUCTS INCLUDE DUCT WRAPPED INSULATION.
- 11. FLEXIBLE DUCT RUN OUTS TO DIFFUSERS SHALL BE INSTALLED FREE OF KINKS AND SAGS. ALL DIFFUSER RUN OUTS SHALL BE SIZED TO MATCH THE INLET OF THE DIFFUSER SERVED (UNLESS NOTED OTHERWISE). MAXIMAM DISTANCE OF 5 FEET.
- 12. TRANSITION RECTANGULAR DUCTWORK ON THE BOTTOM AND THE SIDES. ITAINTAIN DUCTWORK LEVEL AND AS HIGH AS POSSIBLE UNLESS NOTED OTHERWISE.
- 13. ALL DUCT CHANGES FROM SQUARE TO ROUND SHALL BE SMOOTH TRANSITIONS. SPIN-INS AT THE END OF CAPPED DUCTS ARE NOT ACCEPTABLE.
- 14. CEILING HEIGHTS MUST BE MAINTAINED. RUN DUCT AS HIGH AS POSSIBLE.
- 15. THE HYAC EQUIPMENT SHALL NOT BE USED FOR CONSTRUCTION HEATING OR COOLING. IF USED THE HYAC SUBCONTRACTOR SHALL PAY THE CLEANING OF THE UNIT AND DUCTWORK TO THE SATISFACTION OF THE ARCHITECT.
- 16. THE HVAC SUBCONTRACTOR SHALL START UP THE HVAC EQUIPMENT AND SHALL PROVIDE A TEST AND BALANCE OF THE SYSTEM.
- 17. HYAC SUBCONTRACTOR SHALL PROVIDE OWNER WITH A WRITTEN ONE (1) YEAR GUARANTEE COVERING ALL LABOR AND MATERIALS FURNISHED AND INSTALLED AS PART OF THIS PROJECT. GUARANTEE SHALL COMMENCE FROM THE DATE OF SUBSTANTIAL COMPLETION.


HVAC SYMBOLS LIST

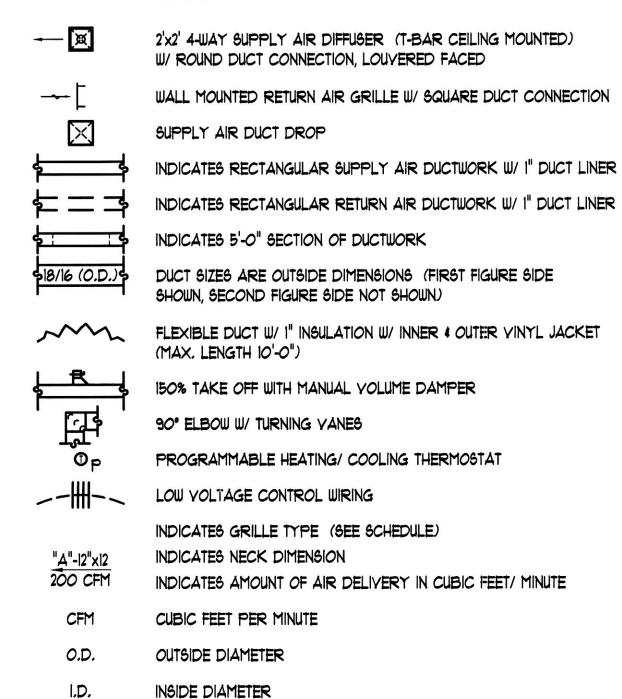


O/A

OUTSIDE AIR

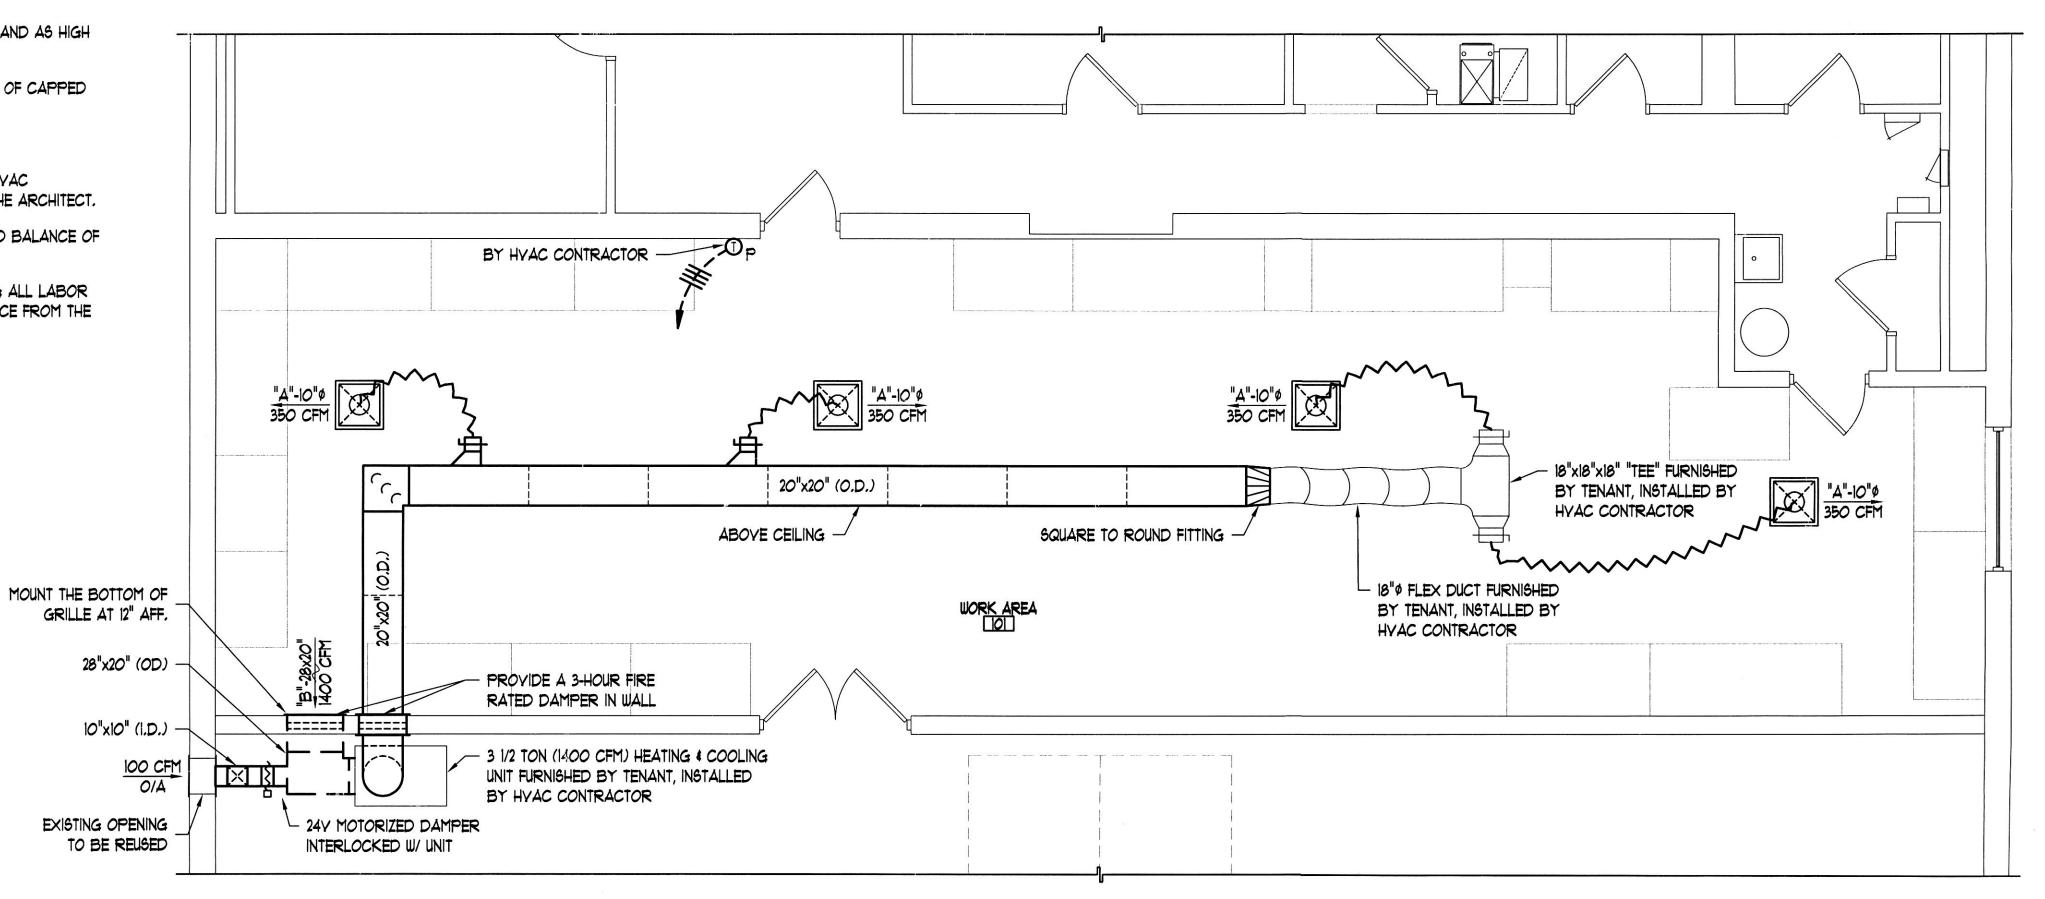

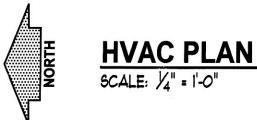

© Evan Lloyd Associates, Inc.

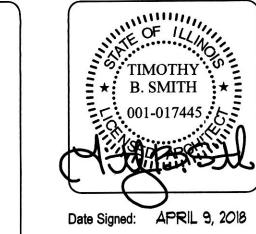

Expiration Date: NOV. 30, 2018

630 South Sixth Street Springfield, Illinois 6270 Phone 217 789 7011



INTERIOR REMODEL

COMPUTER BANK
1545 NORTH 11TH STREET
SPRINGFIELD, ILLINOIS

Date: APRIL 9, 2018

Project No. 18-021

Drawn By: TCR , BH

Revised

Revised: SHEET

HV-1

OF 5 SHEETS